
Belmont Public Library

Library Building Committee Meeting #10 July 11, 2023





Agenda


- 1. Welcome Public
- 2. Approve 6/13/2023 Meeting Minutes
- 3. Invoices
- 4. Project Update
- 5. Design Update
 - a. Schedule
 - b. Building Square Footage Comparison
 - c. 100% Design Development Deliverable
 - d. Exterior and Interior Updates
 - e. Food & Beverage / Grab-and-Go
- 6. Public Comment
- 7. Adjourn

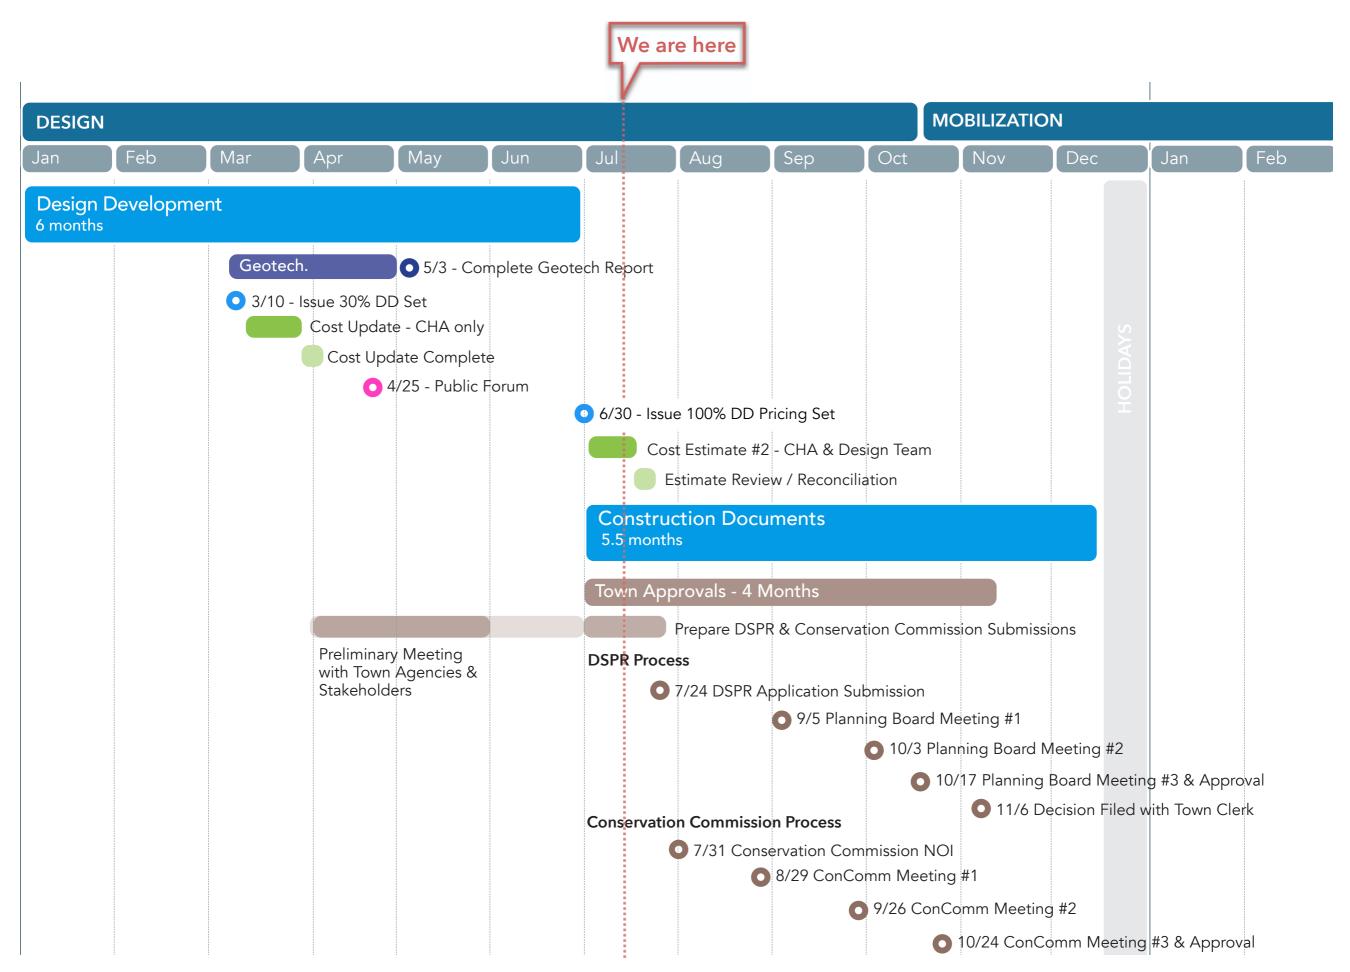

Project Schedule Design Development

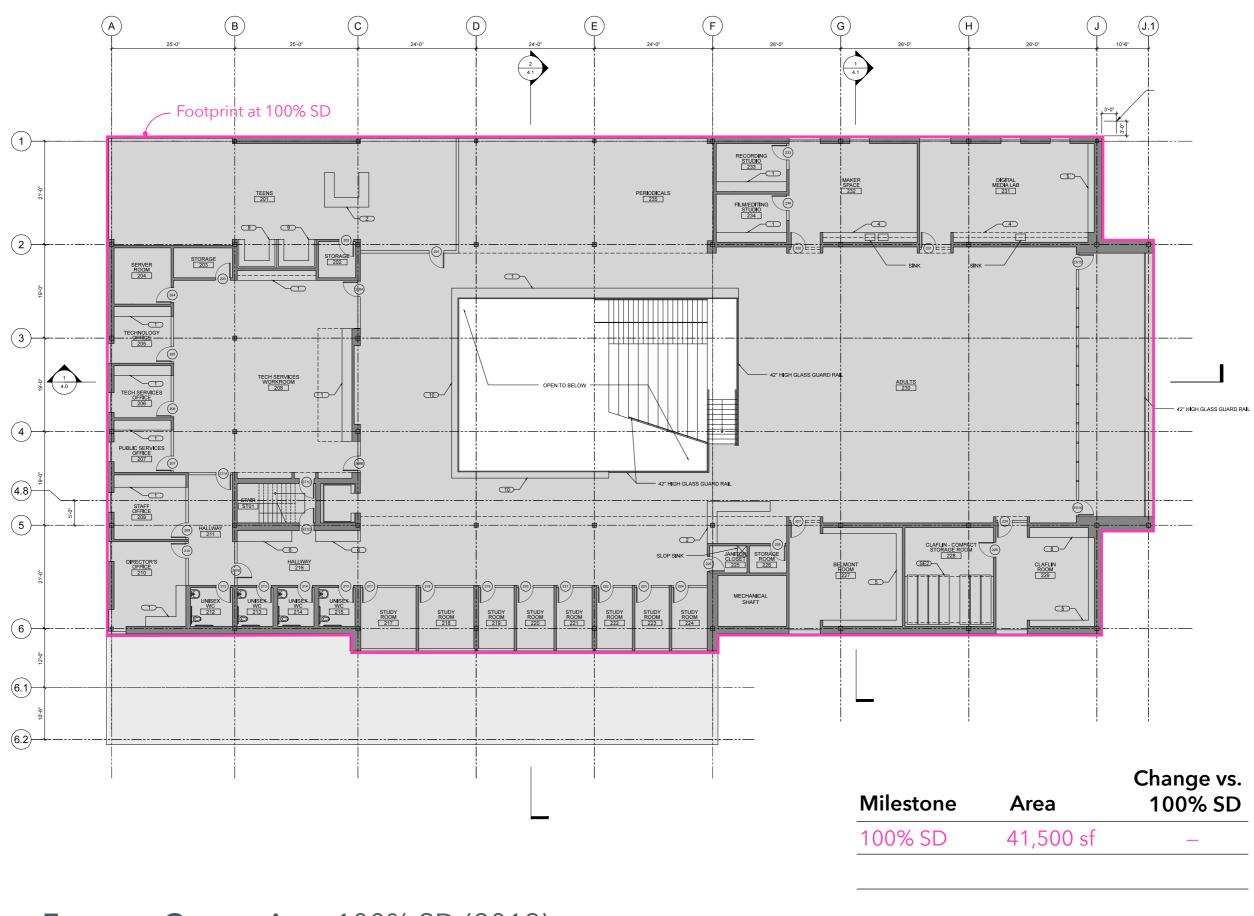

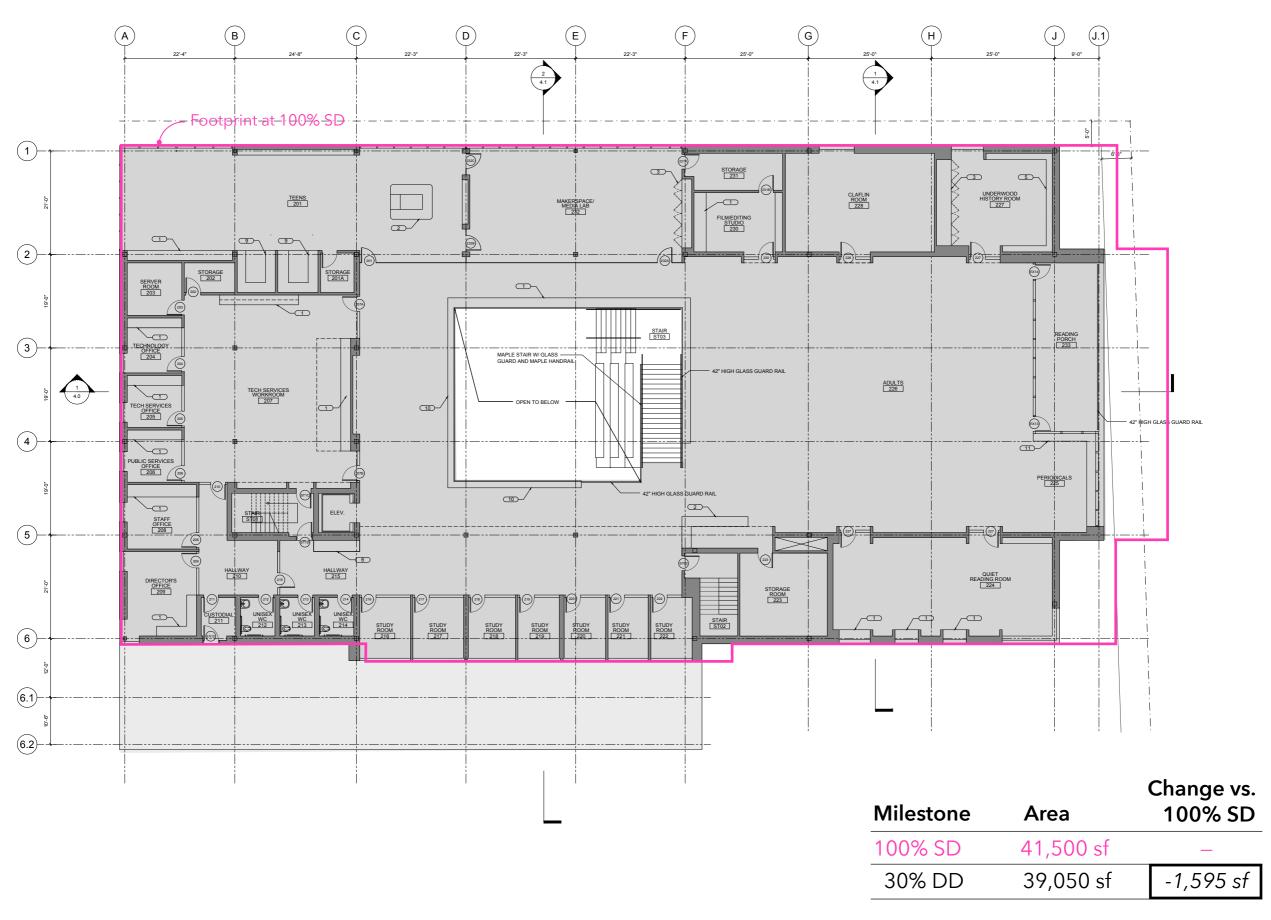

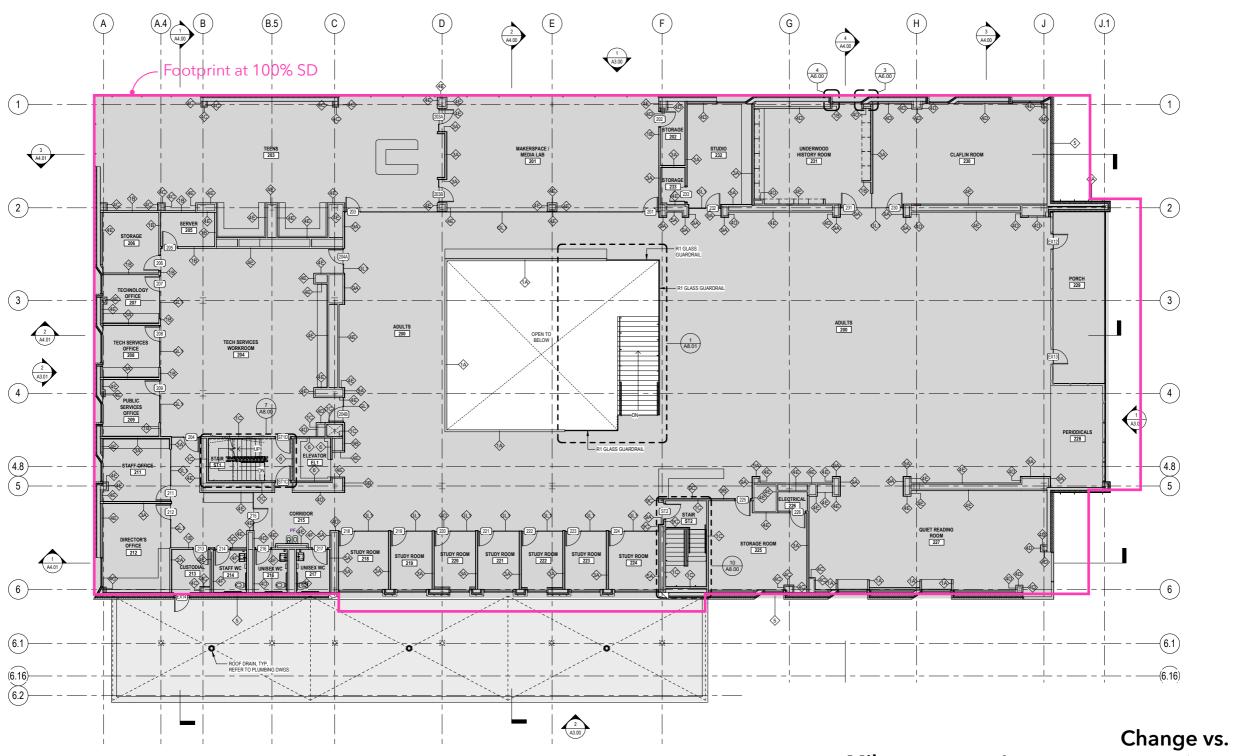

Milestone	Area	100% SD
100% SD	41,500 sf	_
30% DD	39,050 sf	-1,595 sf
100% DD	40,460 sf	-1,140 sf

BELMONT PUBLIC LIBRARY

336 CONCORD AVE, BELMONT, MA 02478



100% DESIGN DEVELOPMENT JUNE 30, 2023



OUDENS ELLO ARCHITECTURE, LLC

46 WALTHAM STREET, SUITE 4A BOSTON, MA 02118 T. 617.422.0980

EXTERIOR ENVELOPE


MEP/FP ENGINEER LIGHTING CODE/LIFE SAFETY

ACOUSTICS

OWNER

OWNER'S PROJECT MANAGER

SPECIFICATIONS

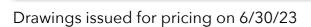



TOWN OF BELMONT 455 CONCORD AVENUE BELMONT, MA 02478 T: 617.993.2640

OWNER'S PROJECT MANAGER:


CHA CONSULTING, INC 1 WASHINGTON MALL, SUITE 1500 BOSTON, MA 02108 T: 617-451-2717

Specifications issued for pricing on 7/7/23

DRAWING LIST

SHEET NO.	SHEET NAME	SHEET NO.	SHEET NAME	SHEET NO.	SHEET NAME	SHEET NO.	SHEET NAME
GENERAL		ARCHITECTURA	AL	MECHANICAL		TELECOM	
G1.0	DRAWING INDEX, ABBREVIATIONS, GENERAL NOTES	A0.01	LEVEL 1 SLAB EDGE PLAN	M0.00	MECHANICAL LEGEND	TT-001	TELECOM SHEET LIST
G2.0	ADA REQUIREMENTS	A0.02	LEVEL 2 SLAB EDGE PLAN	M0.01	MECHANICAL GENERAL NOTES	TT-002	TELECOM ABBREVIATIONS, NOTES & SYMBOLS PAGES
		A0.03	PENTHOUSE/LOW ROOF SLAB EDGE PLAN	M1.01	MECHANICAL GROUND FLOOR PLAN	TT-003	TELECOM ABBREVIATIONS, NOTES & SYMBOLS PAGES
CIVIL		A0.04	HIGH ROOF SLAB EDGE PLAN	M1.02	MECHANICAL SECOND FLOOR PLAN	TT-004	TELECOM SCOPE OF WORK
C0.0	CIVIL NOTES, ABBREVIATIONS, AND LEGEND	A1.01	LEVEL 1 FLOOR PLAN	M1.03	MECHANICAL LOW ROOF PLAN	TT-101	TELECOM OVERALL PLAN - LEVEL 1
C1.0	SITE EROSION AND SEDIMENT CONTROL PLAN	A1.02	LEVEL 2 FLOOR PLAN	M2.01	MECHANICAL VRF PIPING DIAGRAM	TT-102	TELECOM OVERALL PLAN - SECOND FLOOR
C2.0	SITE UTILITY DEMOLITION PLAN	A1.03	PENTHOUSE / LOW ROOF PLAN	M3.01	MECHANICAL DETAILS	TT-102	TELECOM OVERALL PLAN - PENTHOUSE / LOW ROOF
C3.0	SITE UTILITY AND DRAINAGE PLAN	A1.04	HIGH ROOF PLAN	M3.02	MECHANICAL DETAILS	TT-103	TELECOM OVERALL PLAN - HIGH ROOF
C4.0	SITE EROSION AND SEDIMENT CONTROL DETAILS	A1.11	LEVEL 1 FINISH PLAN	M3.03	MECHANICAL DETAILS	TT-400	TELECOM OVERALE PLAN - HIGH ROOP TELECOM ENLARGED PLAN
C4.0 C4.1	SITE UTILITY DETAILS	A1.12	LEVEL 2 FINISH PLAN	M4.01	MECHANICAL SCHEDULES	TT-500	TELECOM PATHWAY RISER DIAGRAM
C4.1 C4.2	SITE UTILITY DETAILS	A1.20	ENLARGED BATHROOM PLANS	M5.00	MECHANICAL CONTROLS	TT-600	TELECOM PATHWAY RISER DIAGRAM
C4.2	SITE UTILITY DETAILS	A2.01	LEVEL 1 REFLECTED CEILING PLAN	M5.01	MECHANICAL CONTROLS	TT-601	TELECOM DETAILS TELECOM DETAILS
LANDOGADE		A2.02	LEVEL 2 REFLECTED CEILING PLAN	M5.02	MECHANICAL CONTROLS		
LANDSCAPE	TREE PROTECTION DI ANI	A2.02 A2.03	PENTHOUSE REFLECTED CEILING PLAN	10.02	WESTATIONE SONTHOES	TT-602	TELECOM DETAILS
L0.0	TREE PROTECTION PLAN			ELECTRICAL		TT-603	TELECOM DETAILS
L1.0	LAYOUT PLAN	A3.00	EXTERIOR ELEVATIONS	E0.00	ELECTRICAL LEGEND AND ABBREVIATIONS	TT-604	TELECOM DETAILS
L2.0	MATERIALS PLAN	A3.01	EXTERIOR ELEVATIONS				
L3.0	GRADING PLAN	A4.00	BUILDING SECTIONS	E1.01	ELECTRICAL GROUND FLOOR POWER PLAN	SECURITY	
L4.0	SOILS PLAN	A4.01	BUILDING SECTIONS	E1.02	ELECTRICAL SECOND FLOOR POWER PLAN	TY-001	SECURITY SHEET LIST
L5.0	PLANTING PLAN	A5.00	WALL SECTIONS	E1.03	ELECTRICAL LOW ROOF POWER PLAN	TY-002	SECURITY ABBREVIATIONS, NOTES & SYMBOLS PAGE
L5.1	PLANTING DETAILS	A5.01	WALL SECTIONS	E1.04	ELECTRICAL HIGH ROOF POWER PLAN	TY-101	SECURITY OVERALL PLAN - LEVEL 1
L6.0	DETAILS	A6.00	TYPICAL EXTERIOR DETAILS	E2.01	ELECTRICAL GROUND FLOOR MECHANICAL EQIP PLAN	TY-102	SECURITY OVERALL PLAN - SECOND FLOOR
L6.1	DETAILS	A6.01	EXTERIOR DETAILS	E2.02	ELECTRICAL \$ECOND FLOOR MECHANICAL EQIP PLAN	TY-103	SECURITY OVERALL PLAN - PENTHOUSE/LOW ROOF
L6.2	DETAILS	A6.10	EXTERIOR PLAN DETAILS	E2.03	ELECTRICAL LOW ROOF MECHANICAL EQIP PLAN	TY-104	SECURITY OVERALL PLAN - HIGH ROOF
		A7.00	INTERIOR ELEVATIONS	E2.04	ELECTRICAL HIGH ROOF MECHANICAL EQIP PLAN	TY-400	SECURITY DIAGRAMS
IRRIGATION		A7.01	INTERIOR ELEVATIONS	E3.01	ELECTRICAL LEVEL 1 REFLECED CEILING PLAN	TY-500	SECURITY CAMERA SCHEDULE
IR.100	IRRIGATION LAYOUT PLAN	A7.02	INTERIOR ELEVATIONS	E3.02	ELECTRICAL LEVEL 2 REFLECED CEILING PLAN	TY-600	SECURITY DETAILS
IR.200	IRRIGATION DETAILS - 1	A7.03	INTERIOR ELEVATIONS	E4.01	ELECTRICAL GROUND FLOOR FIRE ALARM PLAN	TY-601	SECURITY DETAILS
IR.201	IRRIGATION DETAILS - 2	A7.04	INTERIOR ELEVATIONS	E4.02	ELECTRICAL \$ECOND FLOOR FIRE ALARM PLAN	TY-602	SECURITY DETAILS
		A7.05	INTERIOR ELEVATIONS	E4.03	ELECTRICAL LOW ROOF FIRE ALARM PLAN	TY-603	SECURITY DETAILS
STRUCTURAL		A7.06	INTERIOR ELEVATIONS	E4.04	ELECTRICAL HIGH ROOF FIRE ALARM PLAN		
S0.00	AXONOMETRIC	A7.07	INTERIOR ELEVATIONS	E5.00	ELECTRICAL POWER AND FIRE ALARM RISER DIAGRAM	AUDIOVISUAL	
S0.01	GENERAL NOTES	A7.08	INTERIOR ELEVATIONS	E6.00	ELECTRICAL \$CHEDULES	TA-001	AUDIOVISUAL SHEET LIST
S0.02	GENERAL NOTES AND ABBREVIATIONS	A8.00	STAIR / ELEVATOR PLANS AND SECTIONS	E7.00	ELECTRICAL DETAILS	TA-002	AUDIOVISUAL ABBREVIATIONS
S0.02 S0.03	LOADING DIAGRAMS	A8.01	LIB COMMONS STAIR PLANS AND DETAILS			TA-002	AUDIOVISUAL SCOPE OF WORK
S0.04	LOADING DIAGRAMS	A8.10	TYPICAL INTERIOR DETAILS	PLUMBING		TA-003	AUDIOVISUAL OVERALL PLAN - LEVEL 1
S0.11	TYPICAL DETAILS	A8.20	MILLWORK DETAILS	P0.00	PLUMBING LEGEND & SCHEDULES	TA-101	AUDIOVISUAL OVERALL PLAN - LEVEL 1 AUDIOVISUAL OVERALL PLAN - SECOND FLOOR
	TYPICAL DETAILS TYPICAL DETAILS	A8.21	MILLWORK DETAILS	P1.00	PLUMBING UNDERGROUND PLAN		
S0.12		A8.22	MILLWORK DETAILS	P1.01	PLUMBING GROUND FLOOR PLAN	TA-201	AUDIOVISUAL OVERALL RCP - LEVEL 1
S0.13	TYPICAL DETAILS	A8.23	MILLWORK DETAILS MILLWORK DETAILS	P1.02	PLUMBING SECOND FLOOR PLAN	TA-202	AUDIOVISUAL OVERALL RCP - SECOND FLOOR
S0.14	TYPICAL DETAILS	A8.23 A8.24	MILLWORK DETAILS MILLWORK DETAILS	P1.02 P1.03	PLUMBING SECOND FLOOR PLAN PLUMBING LOW ROOF PLAN	TA-203	AUDIOVISUAL OVERALL RCP - PENTHOUSE
S0.15	TYPICAL DETAILS					TA-400	AUDIOVISUAL ENLARGED PLAN
S0.16	TYPICAL DETAILS	A8.25	MILLWORK DETAILS	P1.04	PLUMBING HIGH ROOF PLAN	TA-401	AUDIOVISUAL ENLARGED PLAN
S1.01	LEVEL 1 FOUNDATION PLAN	A8.30	SIGNAGE DETAILS	P2.00	PLUMBING ENLARGED PLANS	TA-402	AUDIOVISUAL ENLARGED PLAN
S1.02	LEVEL 2 FRAMING PLAN	A9.00	EXTERIOR WALL AND ROOF ASSEMBLIES	P3.00	PLUMBING DETAILS	TA-403	AUDIOVISUAL ENLARGED PLAN
S1.03	LOW ROOF FRAMING PLAN	A9.01	INTERIOR PARTITION TYPES			TA-404	AUDIOVISUAL ENLARGED PLAN
S1.04	HIGH ROOF FRAMING PLAN	A9.02	FLOOR AND CEILING ASSEMBLIES	FIRE PROTECTI		TA-500	AUDIOVISUAL SYSTEM BLOCK DIAGRAM
S3.01	COLUMN SCHEUDLE	A9.10	DOOR SCHEDULE & DOOR TYPES	FP0.00	FIRE PROTECTION LEGEND & SCHEDULES	TA-501	AUDIOVISUAL SYSTEM BLOCK DIAGRAM
S3.02	COLUMN DETAILS	A9.11	EXTERIOR WINDOW TYPES & DETAILS	FP1.01	FIRE PROTECTION GROUND FLOOR PLAN	TA-502	AUDIOVISUAL SYSTEM BLOCK DIAGRAM
S4.01	MOMENT FRAME ELEVATIONS	A9.12	EXTERIOR WINDOW TYPES & DETAILS	FP1.02	FIRE PROTECTION SECOND FLOOR PLAN	TA-600	AUDIOVISUAL DETAILS
S4.02	MOMENT FRAME ELEVATIONS	A9.14	ROOM FINISH SCHEDULE	FP1.03	FIRE PROTECTION LOW ROOF PLAN		
S5.01	FOUNDATION AND SECTION DETAILS	A10.01	LEVEL 1 FURNITURE PLAN	FP2.00	FIRE PROTECTION DETAILS		
S6.01	SECTIONS AND DETAILS	A10.02	LEVEL 2 FURNITURE PLAN				
S6.02	SECTIONS AND DETAILS						
DEMO							
D1.1	DEMOLITION SITE PLAN						
D1.2	DEMOLITION LEVEL 1 PLAN						
D1.3	DEMOLITION LEVEL 2 PLAN						

100% DD Documents Drawing List

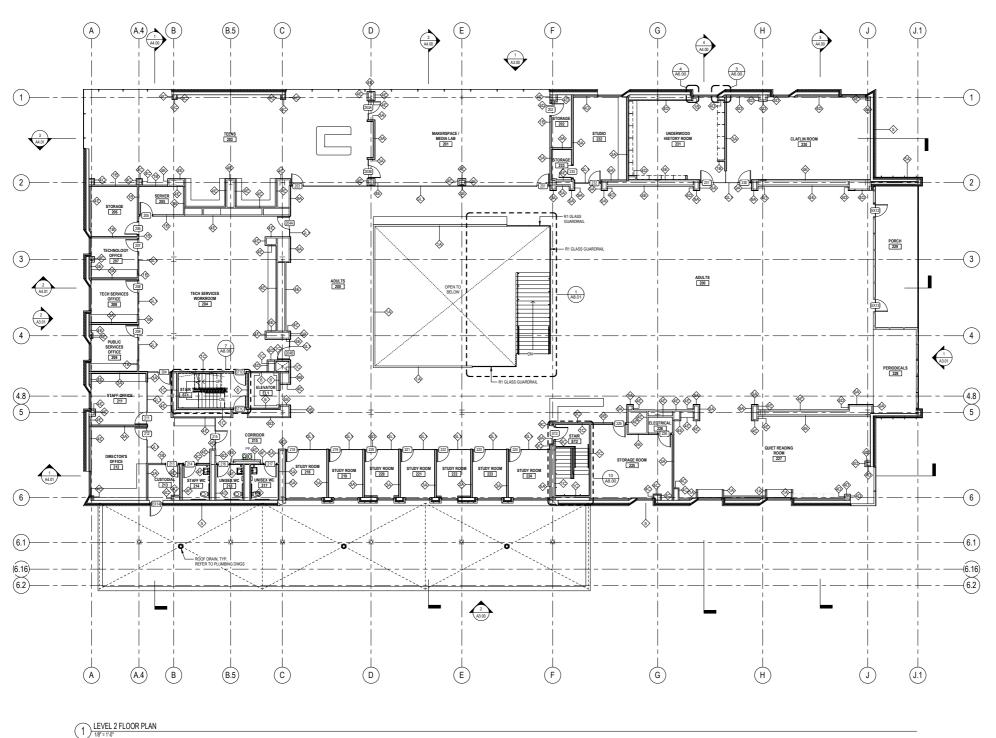

FALL ARREST ANCHOR (RELEASED WELD TO


GENERAL NOTES

- ALL WORK PERFORMED SHALL COMPLY WITH THE CONTRACT DOCUMENTS, DRAWINGS AND SPECIFICATIONS, INCLUDING THESE GENERAL MOTES. THE CONTRACTOR SHALL COORDINATE THE INTENT OF THE GENERAL MOTES WITH ALL TRADES.
- SPECIFICATIONS, BOUND SEPARATELY, ARE PART OF THE CONTRACT DOCUMENTS.
- THE ORGANIZATION OF THE DRAWINGS AND SPECIFICATIONS SHALL NOT CONTROL THE CONTRACTOR IN DIVING THE WORK AMONG SUBCONTRACTORS OR ESTABLISHING THE EXTENT OF THE WORK TO BE PERFORMED BY ANY TRADE UNLESS SPECIFICALLY REQUIRED.
- 4. The switzeout and voronomensine Shalet Control for the Johnson Shalet Shalet Control is Found between Delawings, General notes, And Specifications, Consult in Architect For Carrication Shalet Shalet
- 5. THE STRUCTURAL MECHANICAL ELECTRICAL, PLUBBING AND FIRE PROTECTION DRAWNINGS AND SUPPLIBERATIVE TO THE MEDITATION LIGHDANISM. STRUME LEST RESERVOIRS IN OF THE SUPPLIES AND SUPPLIES AND SUPPLIES AND SUPPLIES AND SUPPLIES. SUPPLIES AND SUPPLIES AND
- DO NOT SCALE DRAWINGS. DIMENSIONS SHALL TAKE PRECEDENCE OVER SCALES SHI DRAWINGS. THE GENERAL CONTRACTOR SHALL VERIFY ALL DIMENSIONS, GRADES, AN CONDITIONS AT THE SITE PRIOR TO COMMENCING WITH THE WORK, AND REPORT ANY DISCREPANCIES TO THE ARCHITECT IN WRITING.
- CONSTRUCTION STANDARDS. IF THE CONTRACTOR HAS QUESTIONS REGARDING THE SAME, O THEIR EXACT MEANING, THE ARCHITECT SHALL BE NOTIFIED FOR CLARIFICATION.
- CONDITIONS ARE THE SAME UNLESS SPECIFICALLY NOTED OR DETAILED OTHERWISE.
- 9. DIMENSIONS ARE TYPICALLY TO FACE OF FINISH UNLESS OTHERWISE NOTED.

 10. EL COR ELEVATIONE ARE TYPICALLY TO TOR OF EINIGHER EL COR LINE ESS OTHER
- 11. CEILING HEIGHT DIMENSIONS ARE TO FINISHED SURFACES.
- ALL CONSTRUCTION SHALL CONFORM TO THE REQUIREMENTS OF THE MASSACHUETTS STATE BUILDING CODE 780 CMR 10TH EDITION.
- HE COMINGLION SHALL PHOVIDE AND INSTALL ALL STIPPENENS, BRACINISS, BLOCKINIG, BUXX.
 PLATES, AND SUPPORTING BOARCEST REQUIRED FOR THE INSTALLATION OF ALL CASHOORK.
 TOLIET ROOM, ACCESSORIES, HAND RAILS, CHAIR RAILS, FIXTURES, AND PARTITIONS, AND WALL
 MOUNTED OR SUSPENDED MECHANICAL, ELECTRICAL, OR MISCELLANEOUS EQUIPMENT AND
 FURNISHINGS.
- 14. MECHANICAL SUPPLY AND RETURN AIR SHAFTS SHALL BE ALRIGHT AND SE
- THE CONTRACTOR SHALL REVIEW THE LOCATION AND THE MOUNTING HEIGHTS OF THE TOILET ROOM ACCESSORIES WITH THE ARCHITECT AND BUILDING INSPECTOR PRIOR TO INSTALLATION TO ASSURE CORRECT POSITIONING IN ACCORDANCE WITH THE AMERICANS WITH DISABILITIES ACT.
- DUCT PENETRATIONS OF FIRE RATED WALLS, FLOORS, OR ROOF SHALL HAVE FIRE DAMPERS PE NFPA. DAMPERS MUST BE LOCATED ON DRAWINGS.
- PERELINATIONS IN WALLS, PLOURS, OR ROUP REQUIRING PROTECTED OPENINGS SHALL BE FIRE STOPPED IN ACCORDANCE WITH NFPA.
- 18. AIR WATER RESISTIVE BARRIER TO BE SEALED AIRTIGHT AND WATERTIGHT AT ALL PENETRATIONS
- ALL LEGAL EXIT DOORS SHALL BE OPERABLE FROM THE INSIDE WITHOUT THE USE OF A KEY OR ANY SPECIAL INDONLEDGE OR EFFORT, AND. SHALL SWING IN THE DIRECTION OF EGRESS. SPECIAL LOCKING DEVICES SHALL BE AN APPROVED TYPE.
- NO MATERIAL OR PRODUCT SUBSTITUTIONS SHALL BE MADE FROM THOSE INDICATED IN THE CONTRACT DOCUMENTS WITHOUT PRIOR REVIEW AND APPROVAL BY THE ARCHITECT
- 21. UNLESS NOTED OTHERWISE, DOORS SHALL BE LOCATED 4" FROM ADJACENT WALL
- 22. REFER TO A1.11, A1.12 AND SCHEDULE A9.14 FOR FINISHES.
- FURNITURE SHOWN FOR REFERENCE ONLY. NOT IN CONTRACT. REFER TO A10.01 AND A10.02 FOR SUGGESTED QUANTITIES.

Date: Scale: Drawn: Checked: Project No:

A2.01

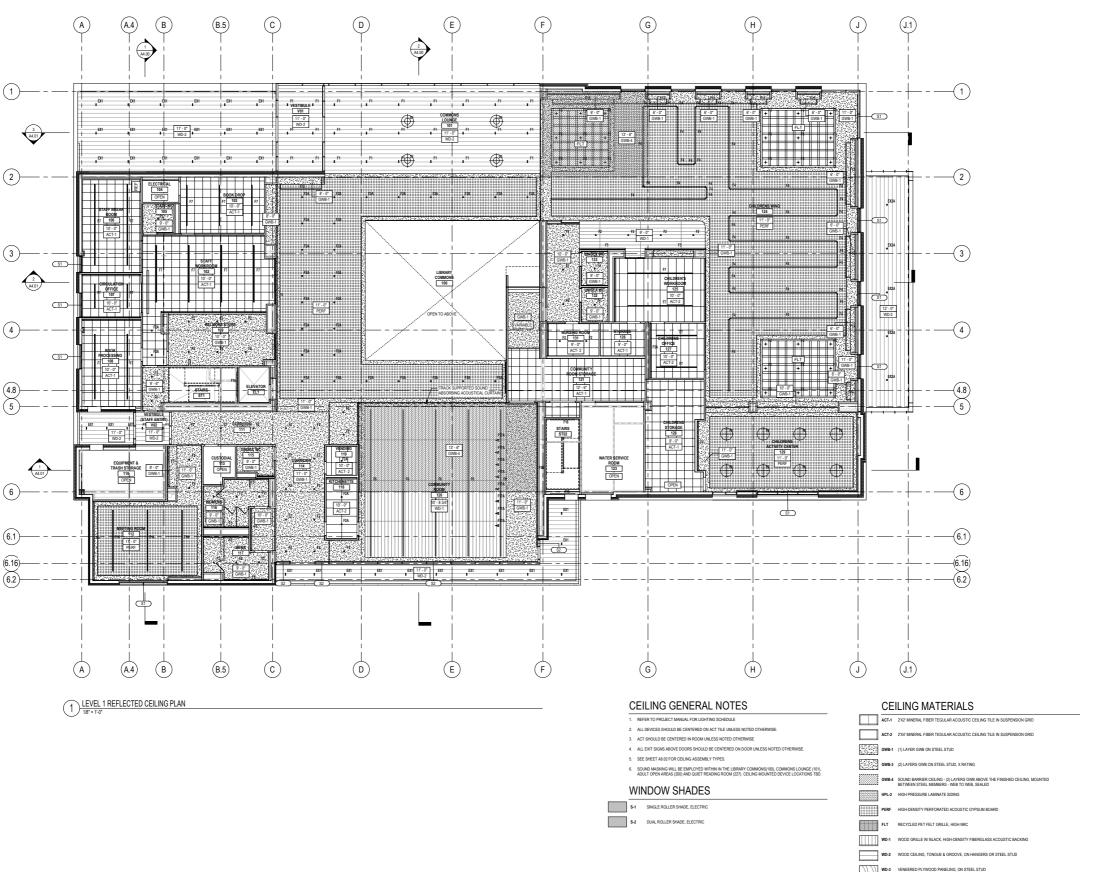

BELMONT PUBLIC LIBRARY
336 Concord Ave, Belmont, MA 02478
Oudens Blo Architecture, LLC
8 Without Stress Sees, Sees, A. Boston MA 02118


EXTERIOR ELEVATIONS

06/30/23 1/8" = 1'-0" Author Checker 2301

Date: Scale: Drawn: Checked: Project No

A3.00

100% DD Documents Exterior Elevations

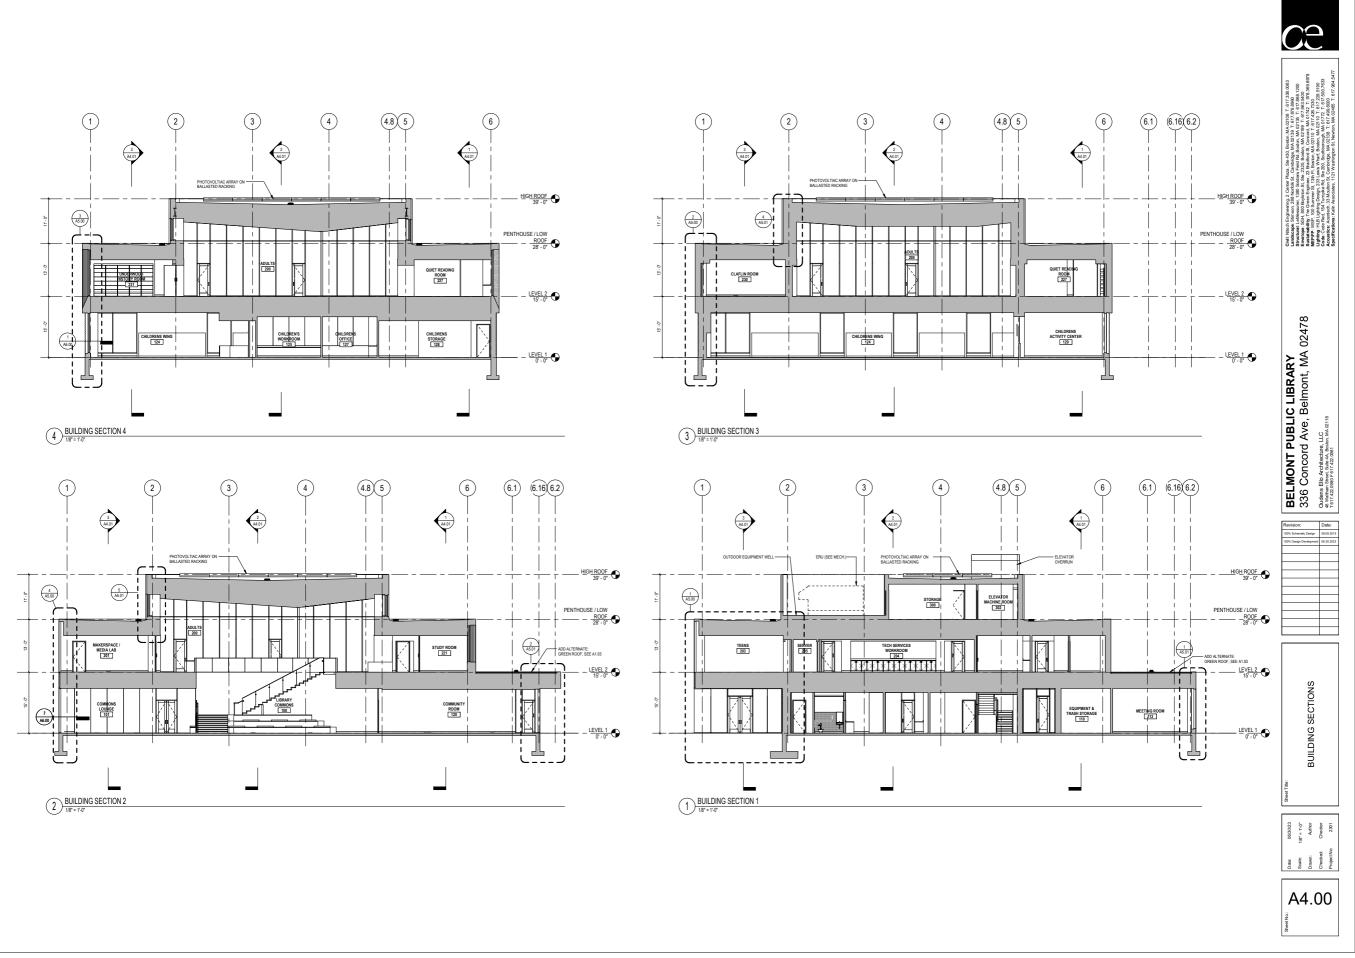














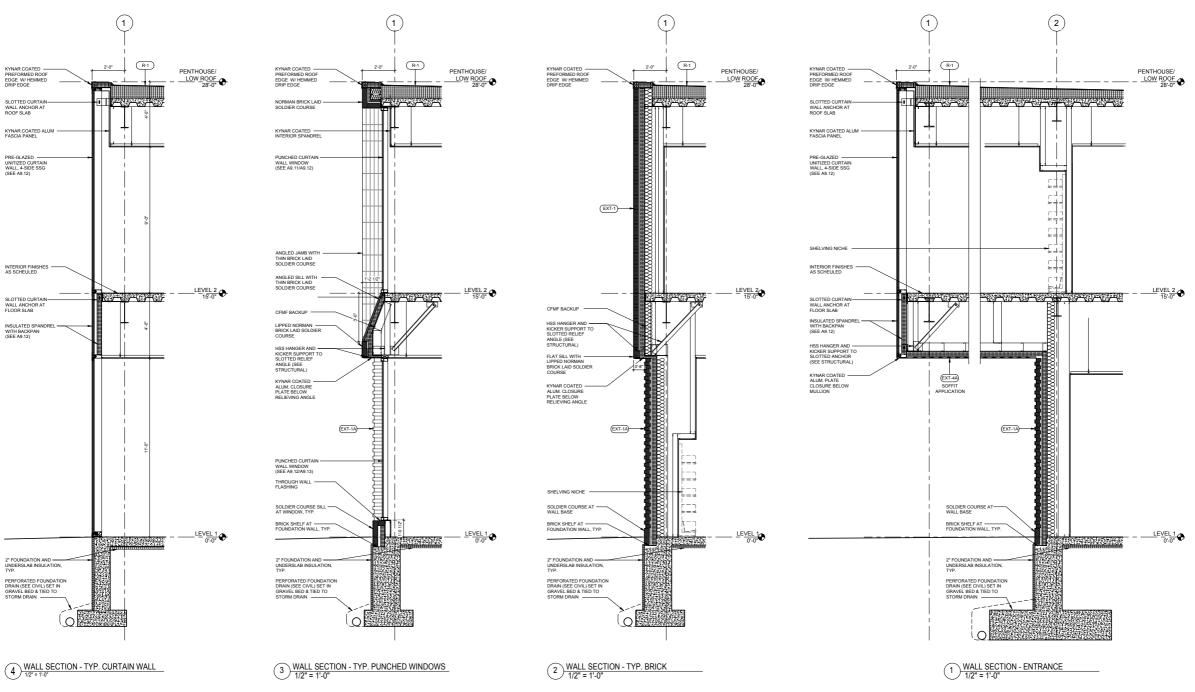


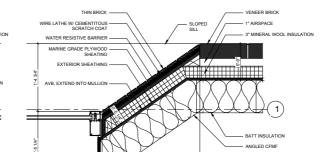

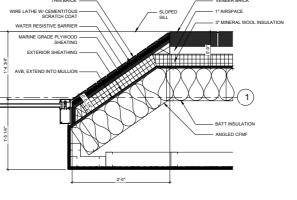

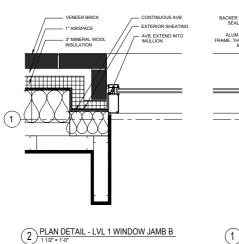

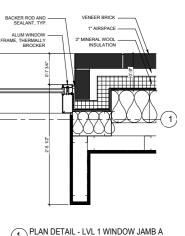

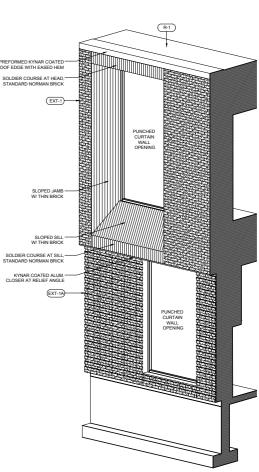



5 AXON - TYP. BRICK WALL AND WINDOW






A6.00

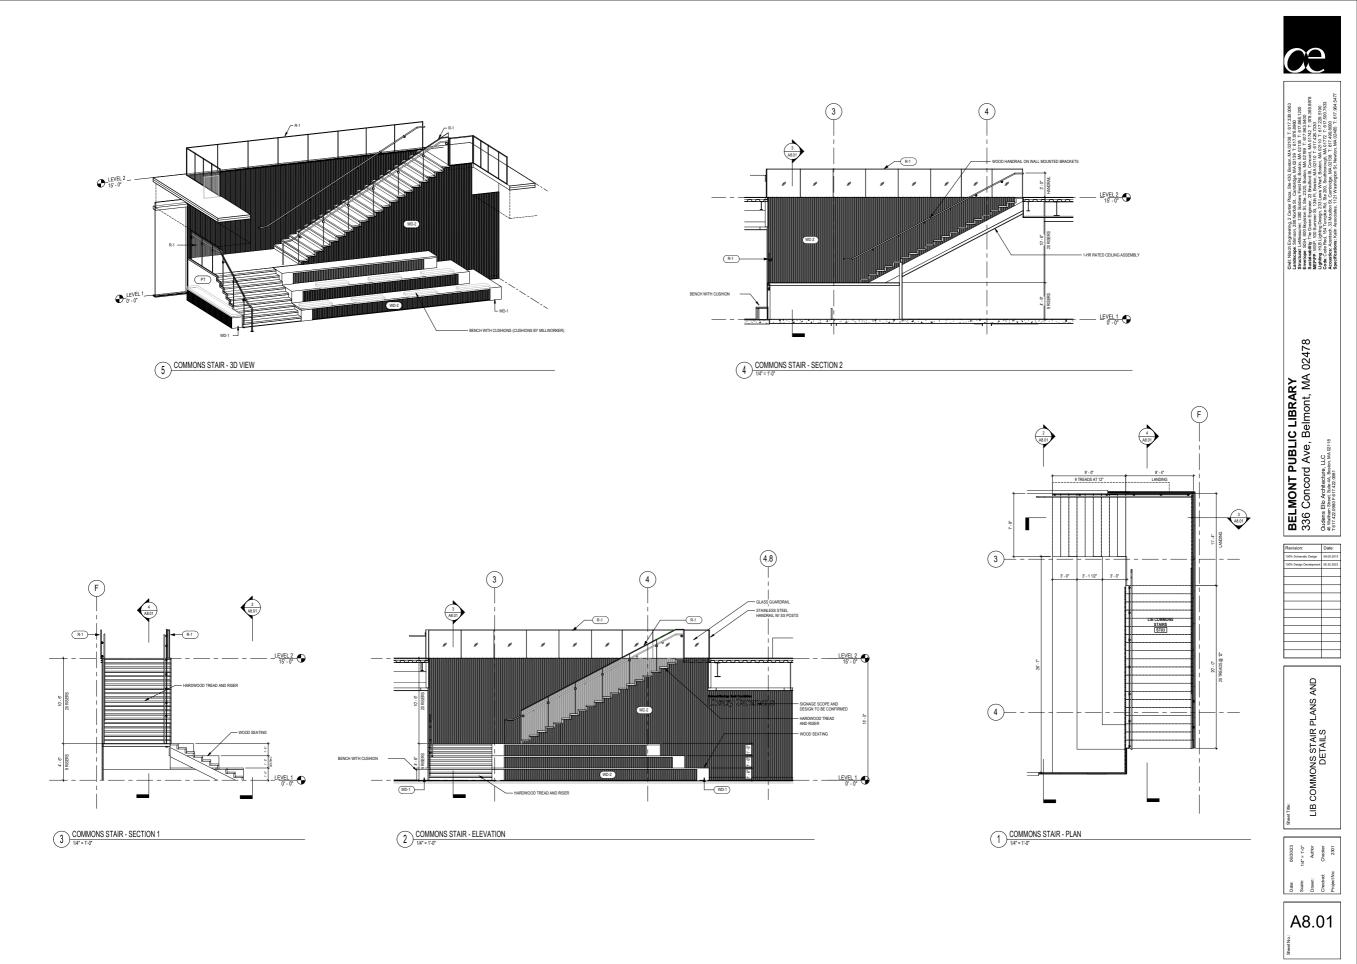


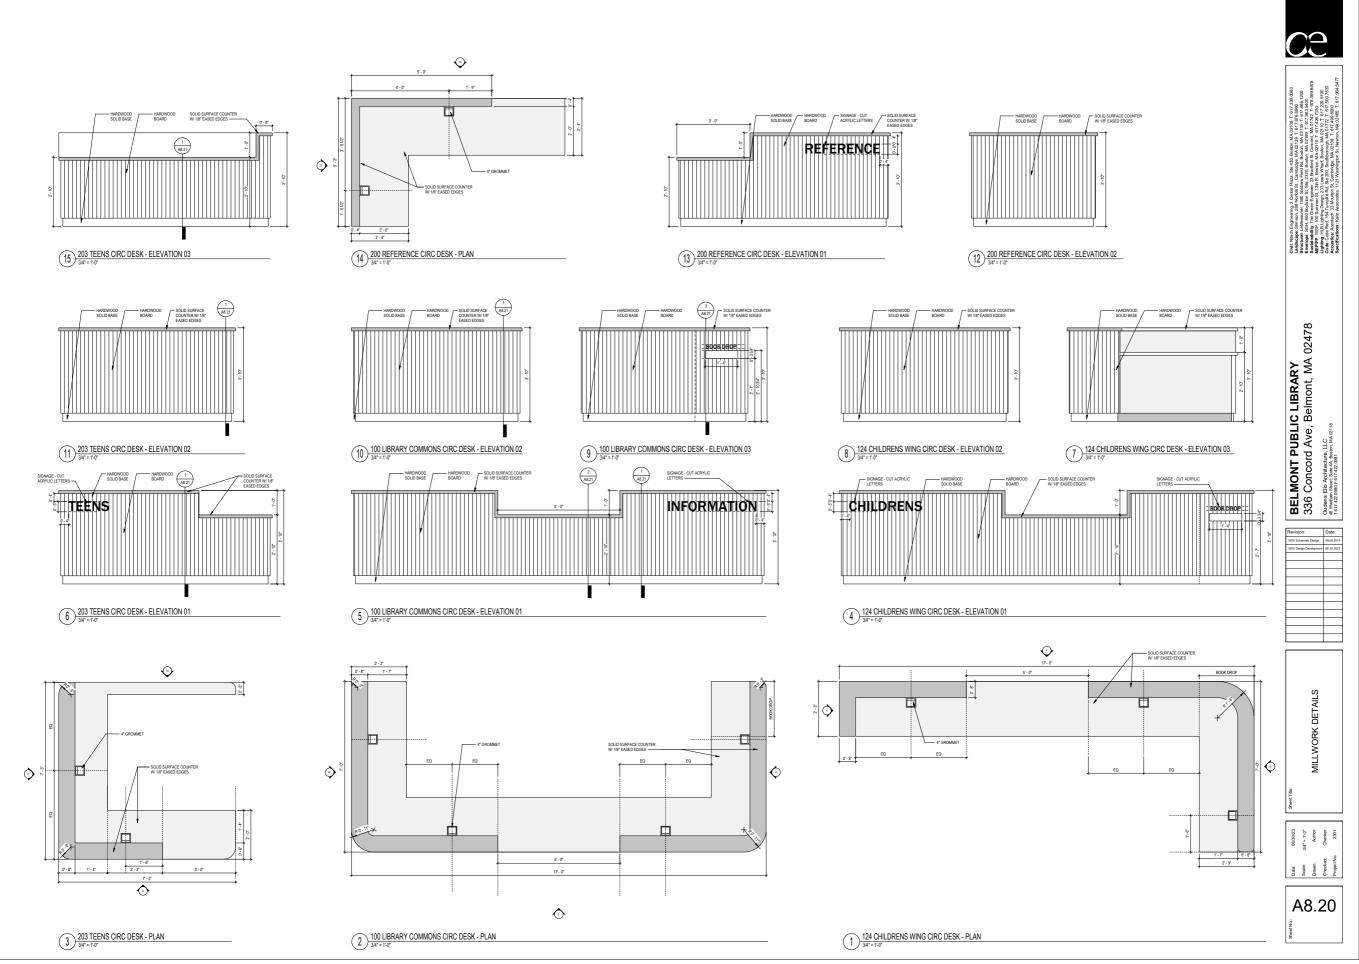


100% DD Documents Millwork

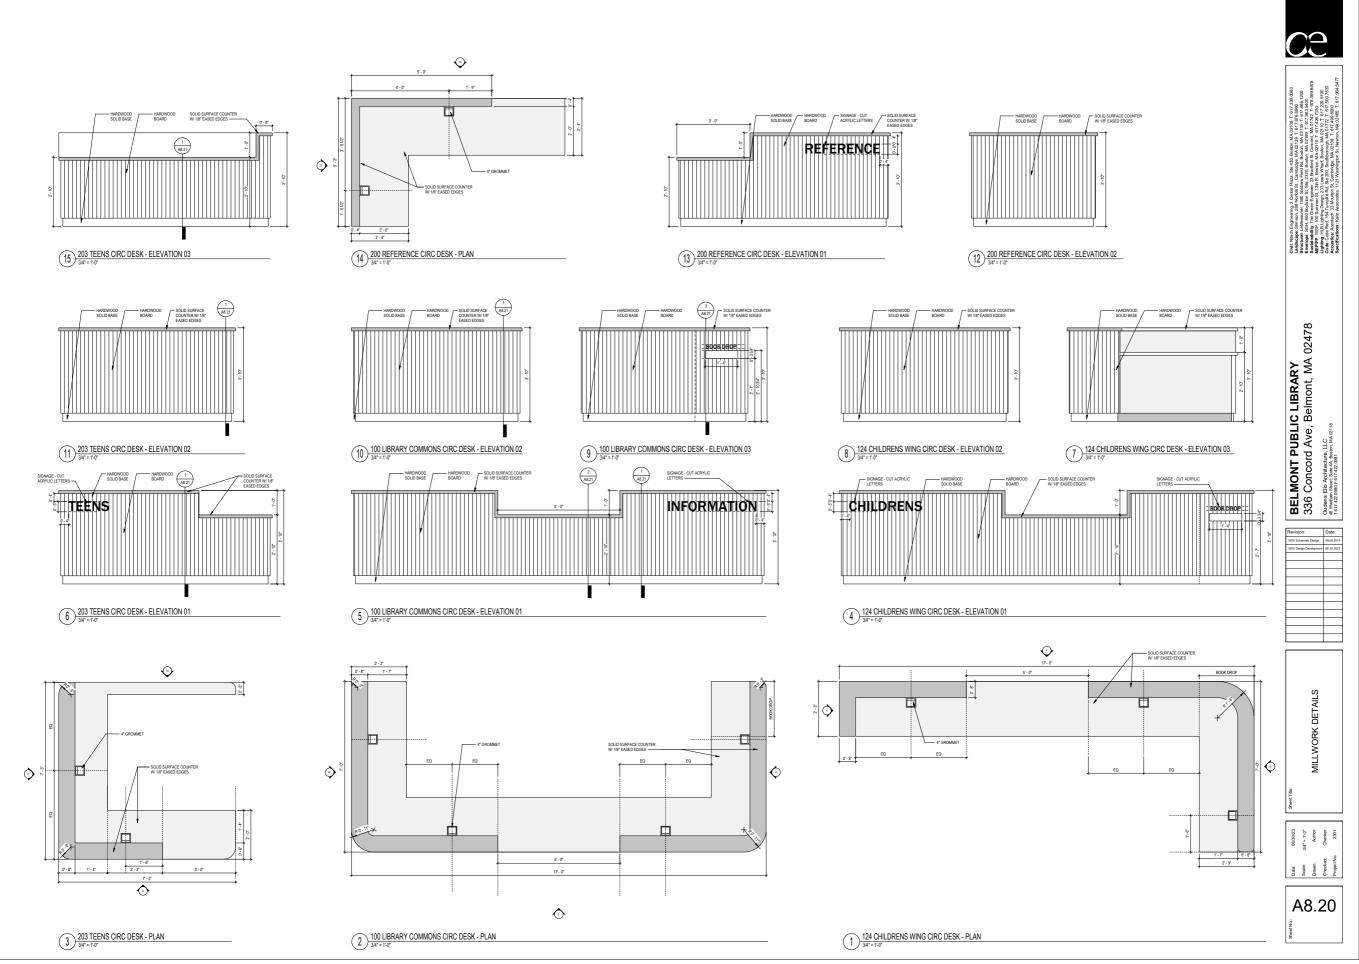

100% DD Documents Millwork

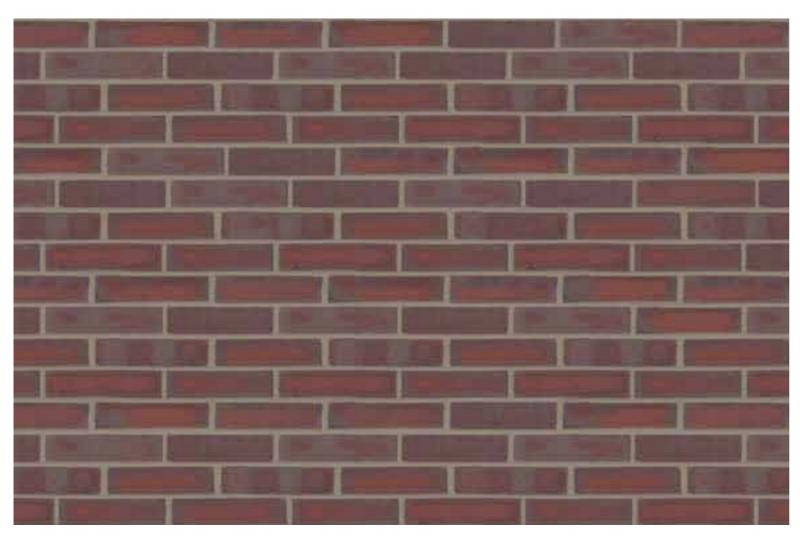

Sioux City 'Cabernet Burgundy' Running Bond

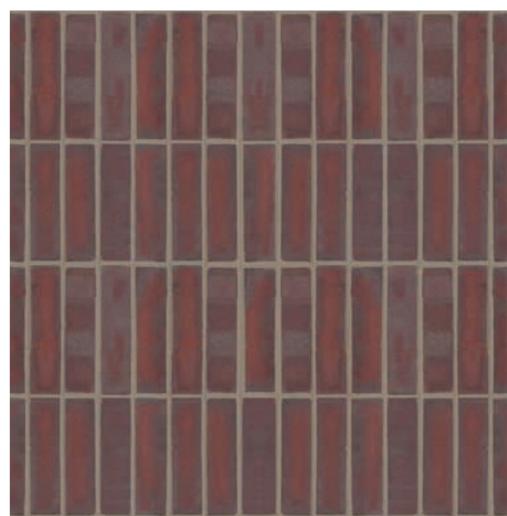


Sioux City 'Cabernet Burgundy' Stack Bond



Recessed Alternating Courses




Recessed Alternating Courses combined with Flush Brick

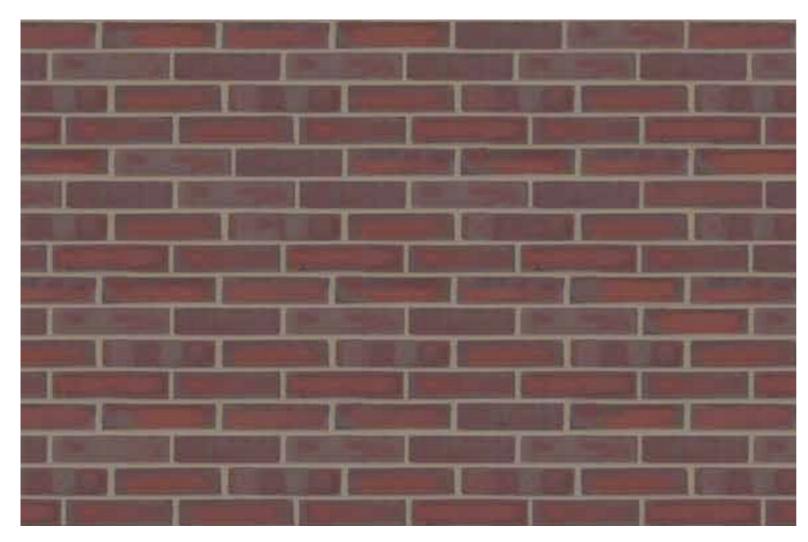

Sioux City 'Cabernet Burgundy' Running Bond



Fundermax 'Enigma' Natural

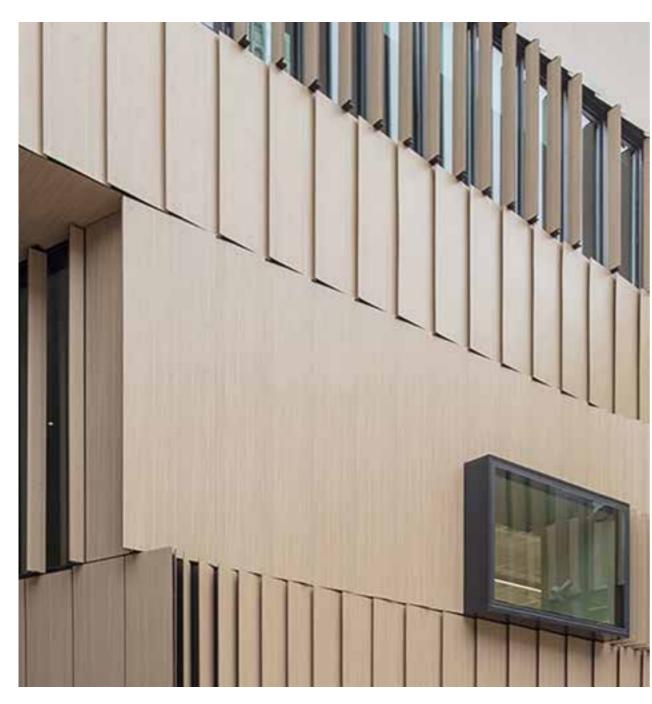



Fundermax Panel Installation (Beaver Country Day School)

Exterior Materials HPL Panel













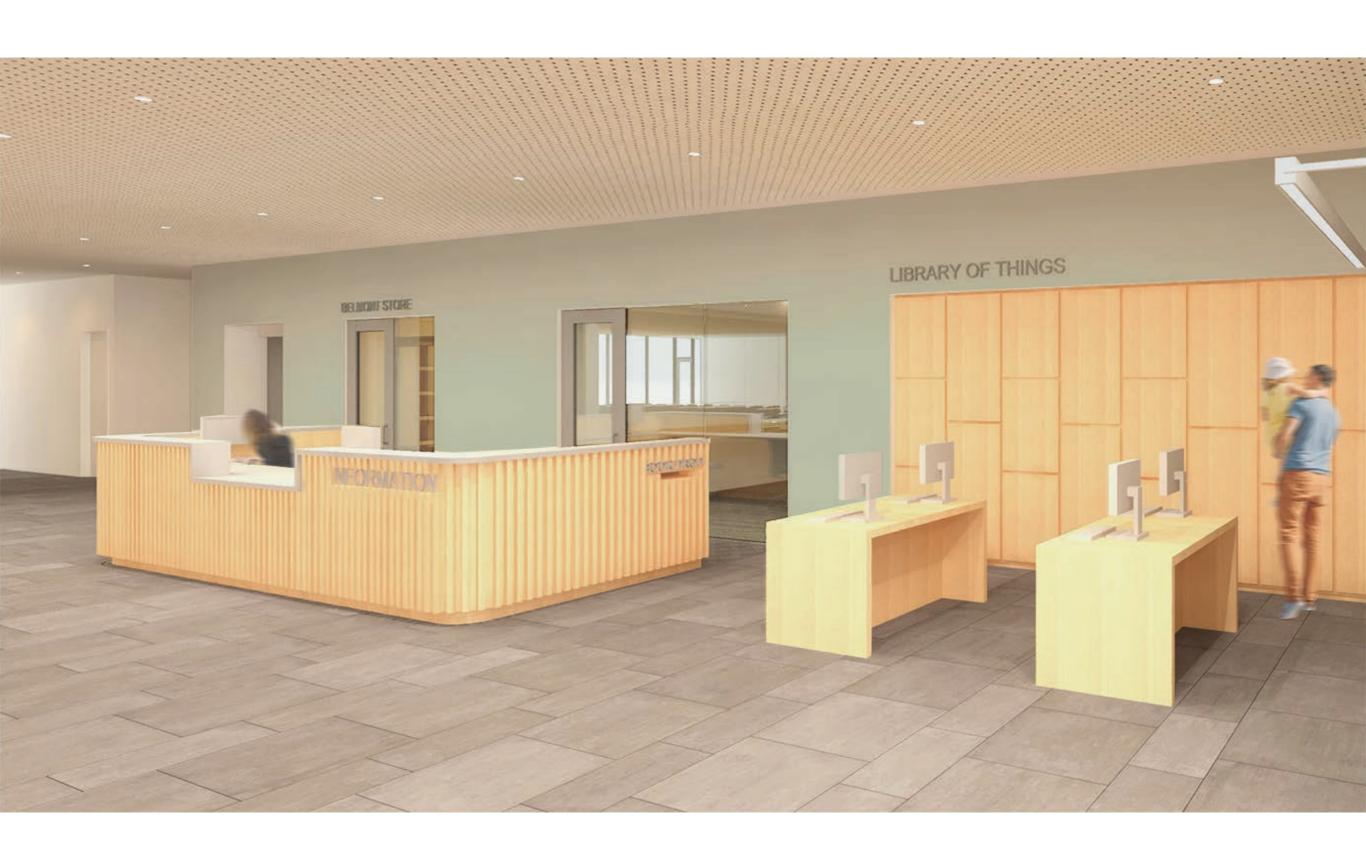

Interior View Information Desk in Commons

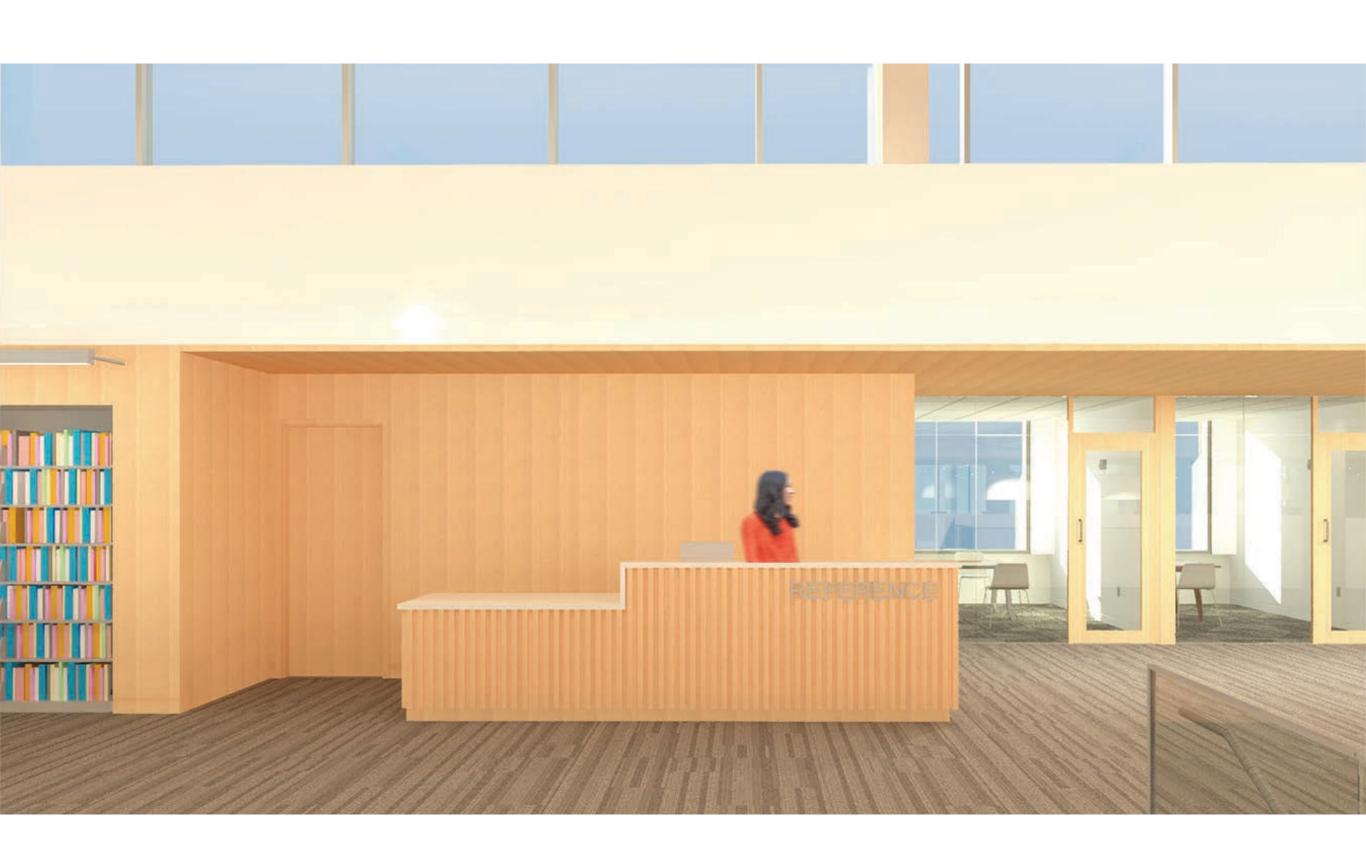

Interior View Reference Desk on Second Floor

Vending



Grab & Go







Ground Floor Plan F&B Offering







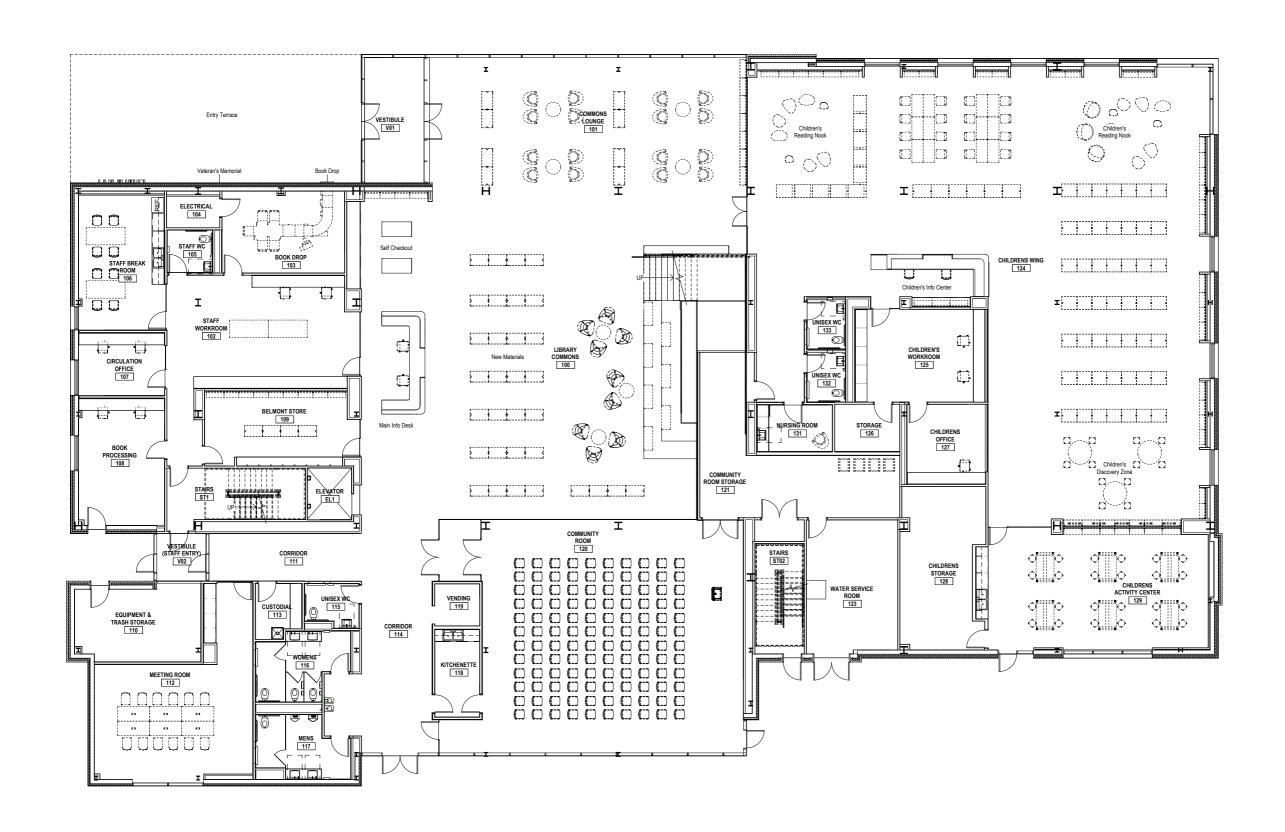

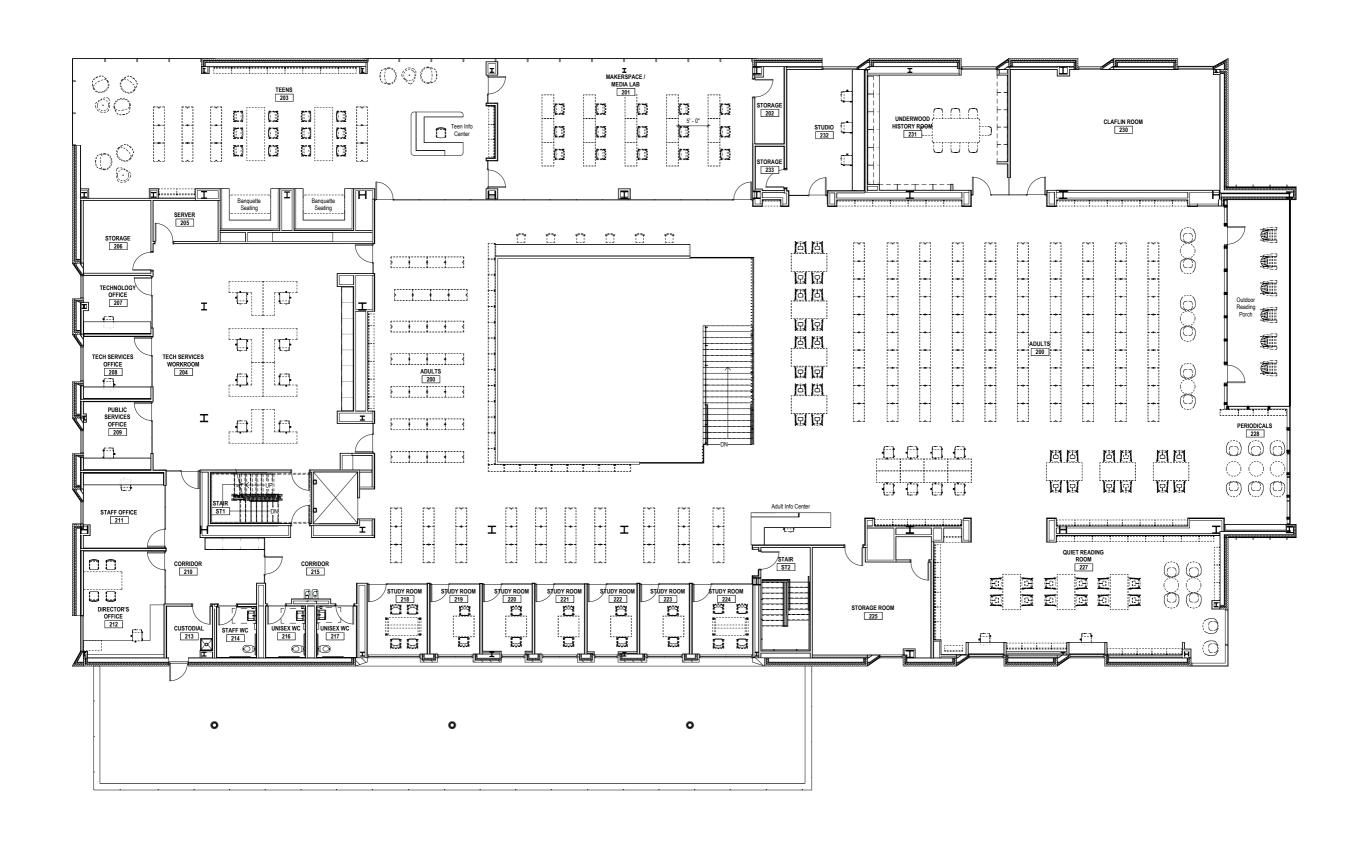



Oudens Ello Architecture